


REPORT

City of Brampton

Street Lighting Design
Denison Avenue Extension
Between Park Street and Mill Street

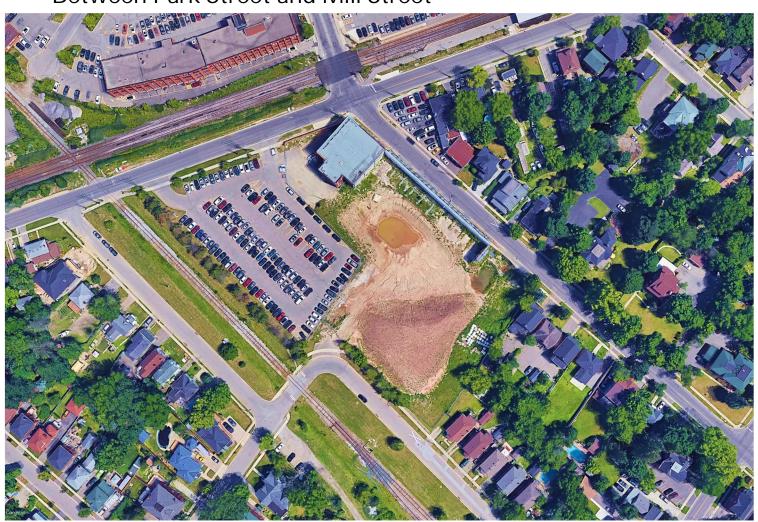

NOVEMBER 2019



CONFIDENTIALITY AND © COPYRIGHT This document is for the sole use of the addressee and Associated Engineering (Ont.) Ltd. The document contains proprietary and confidential information that shall not be reproduced in any manner or disclosed to or discussed with any other parties without the express written permission of Associated Engineering (Ont.) Ltd. Information in this document is to be considered the intellectual property of Associated Engineering (Ont.) Ltd. in accordance with Canadian copyright law. This report was prepared by Associated Engineering (Ont.) Ltd. for the account of City of Brampton. The material in it reflects Associated Engineering (Ont.) Ltd.'s best judgement, in the light of the information available to it, at the time of preparation. Any use which a third party makes of this report, or any reliance on or decisions to be made based on it, are the responsibility of such third parties. Associated Engineering (Ont.) Ltd. accepts no responsibility for damages, if any, suffered by any third party as a result of decisions made or actions based on this report.

City of Brampton Table of Contents

TABLE OF CONTENTS

SEC	CTION	PAGE NC
Tab	ole of Contents	i
List	t of Tables	ii
List	t of Figures	iii
1	Introduction	1
2	Analysis	1
	2.1 Denison Extension	1
3	Recommendations	2
	3.1 Denison Extension	2
_		

Appendix A – Lighting Plan (Roundabout and Corridor)



City of Brampton List of Tables

LIST OF TABLES

	PAGE NO
Гable 2-1: Recommended RP-8-14 Luminance Values for Proposed Roadway	1
Table 2-2: Calculated Luminance Values for Proposed Roadway (Medium Pedestrian Conflict Area)	1



City of Brampton List of Figures

LIST OF FIGURES

PAGE NO.

Figure 2-1: Denison Extension - Model Rendering

2

1 INTRODUCTION

The City of Brampton requested that Associated Engineering complete a lighting assessment to add street lighting for the proposed Denison Avenue extension. The scope of the project includes approximately 100m of local roadway connecting Park Street and Mill Street.

2 ANALYSIS

A photometric analysis for this project, was prepared based on the following assumptions:

- The extension (and surrounding streets) were considered as local streets.
- The extension (and surrounding streets) were considered medium pedestrian conflict areas (11-100 people average annual peak hour of darkness, typically between 6-7 p.m.)
- Existing hydro poles and proposed lighting poles will be used for placing luminaires.
- Mounting height of luminaires will be 7.62m/25ft (standalone pole mounted).
- GE Evolve LED Roadway Streetlight ERL1 (8000 lumen) fixtures/IES files has been used for all photometric analysis, based on previous projects completed for the city

2.1 Denison Extension

The following tables compare the resulting lighting levels of the proposed fixtures, with the recommended levels under RP-8-14 for roadways.

Table 2-1: Recommended RP-8-14 Luminance Values for Proposed Roadway

Area	Min. Lavg cd/m2	Max. Lavg / Lmin	Max. Lmax / Lmin
Denison Extension (Local – Medium Pedestrian Conflict)	0.5	6.0	10.0

Table 2-2: Calculated Luminance Values for Proposed Roadway (Medium Pedestrian Conflict Area)

Area	Min. Lavg cd/m2	Max. Lavg / Lmin	Max. Lmax / Lmin
Denison Extension (Local – Medium Pedestrian Conflict)	0.74	3.70	9.5

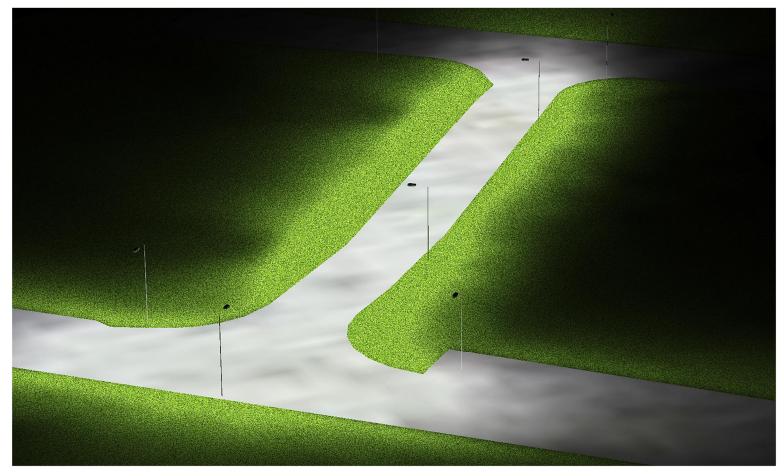


Figure 2-1: Denison Extension - Model Rendering

3 RECOMMENDATIONS


3.1 Denison Extension

Reviewing the results of the photometric model, the horizontal pavement luminance and uniformity ratios (Average/Min & Max/Min) of the roadway are acceptable and adhere to RP-8-14 (Guide to Roadway Lighting) requirements. To achieve optimum roadway uniformity and lighting, we recommend proceeding with our luminaire design.

Appendix A – Lighting Plan (Roadway/Extension)

KEY MAP

STREETLIGHT SYMBOLS LEGEND

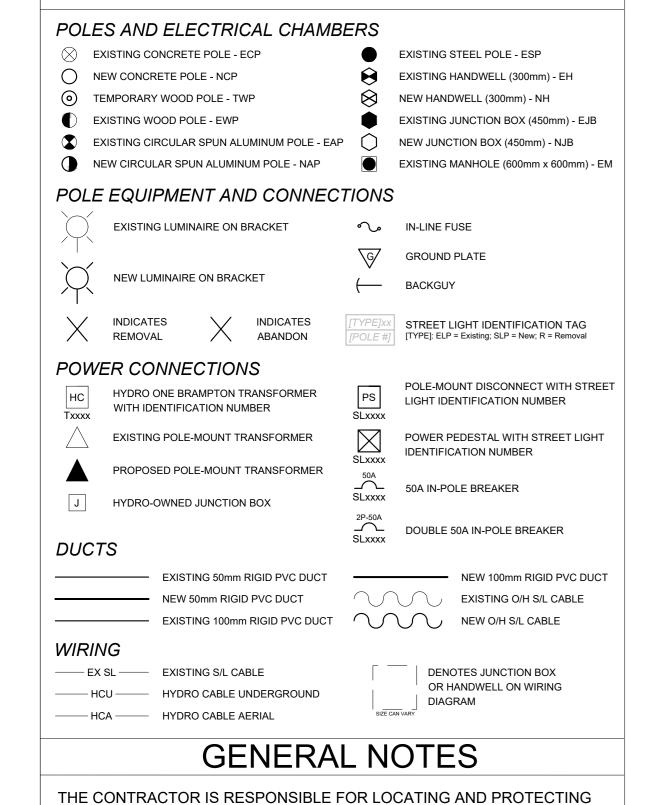


ALL EXISTING UTILITIES PRIOR TO AND DURING CONSTRUCTION. THE ACCURACY OF THE POSITION OF SUCH UTILITIES AND STRUCTURES IS

NOT GUARANTEED. BEFORE STARTING WORK, THE CONTRACTOR SHALL CONFIRM THE EXACT LOCATION OF ALL SUCH UTILITIES AND STRUCTURES AND SHALL ASSUME ALL LIABILITY FOR DAMAGE OF THEM.

THE CONTRACTOR SHALL MAINTAIN EXISTING ILLUMINATION AT ALL

ALL WORK TO BE COORDINATED WITH CITY OF BRAMPTON

REPRESENTATIVE.

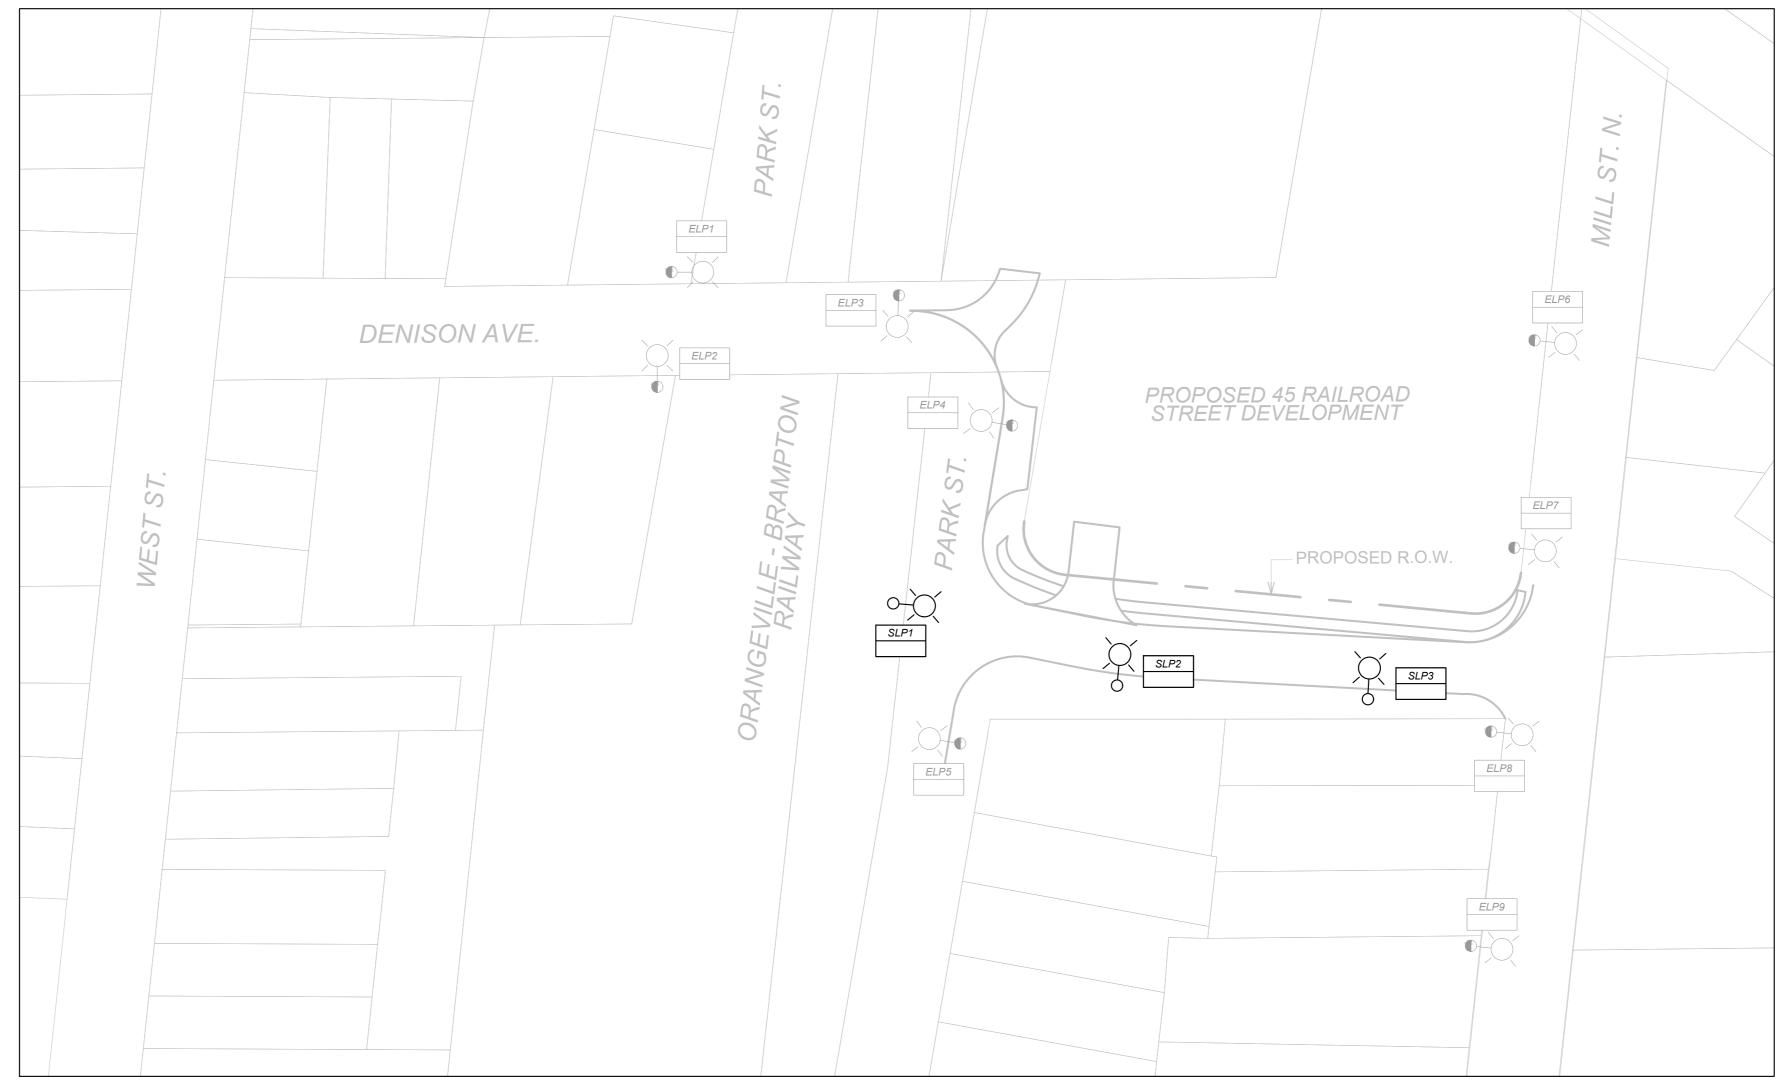

PLAN **DENISON AVENUE EXTENSION**

CONTRACT NO: T2019-070

NOTES STREET LIGHT POLE DETAILS

SCHEDULE OF APPROVALS NO. DATE BY DESCRIPTION CHECKED BY SCALE: NTS DESIGNED BY: C.W. CHECKED BY: E.M. DATE: NOVEMBER 1, 2019 APPROVAL:

APPROVAL DATE:





DENISON AVENUE EXTENSION BETWEEN PARK STREET AND MILL STREET LIGHTING LAYOUT

DWG. NO.: EL 1

SIGNATURES

PREPARED BY

Connor Whitehouse

Electrical, Instrumentation & Controls Designer

REVIEWED AND APPROVED BY



Don Bai, P.Eng.

Manager, Electrical, Instrumentation & Controls